SECRETARIAT OF THE KULHUDHUFFUSHI CITY COUNCIL

## DRAWING INDEX

ARCHITECTURA	L		
SHEET NUMBER	CONTENTS		
A-001	COVER & INDEX SHEET		
A-101	SITE PLAN - BOAZIYAARAIH AREA		
A-102	SITE PLAN - ATOLL COUNCIL AREA		
A-103	RAIN GARDEN LAYOUT		
A-104	CULVERT LAYOUT		
A-301	RAIN GARDEN SECTION DETAILS		
A-401	CULVERT START DETAILS		
A-402	CULVERT MIDDLE DETAILS		
A-403	CULVERT END DETAILS		
A-404	CULVERT END DETAILS		
A-501	SLUICE GATE SAMPLE		

STRUCTURAL	
SHEET NUMBER	CONTENTS
S-401	JUNCTION PIT DETAILS
S-402	COLLECTION PIT DETAILS
S-501	TYPICAL DETAILS

INDEX LEGEND	
SERIES	DESCRIPTION
000	GENERAL
100	PLANS
200	ELEVATIONS
300	SECTIONS
400	DETAILS
500	SCHEDULES AND DIAGRAMS

### GENERAL NOTES

- ALL DRAWINGS MUST BE READ IN CONJUNCTION WITH THE BILL OF QUANTITIES AND THE PROJECT SPECIFICATIONS
- 2. DIMENSIONS INDICATED ON THE DRAWINGS SHALL GOVERN; DO NOT SCALE DIMENSIONS FROM THE DRAWINGS
- 3. REPORT ANY DISCREPANCIES, OMISSIONS, OR AMBIGUITIES TO THE PROJECT SUPERVISOR BEFORE COMMENCING WORK
- 4. ALL MATERIALS AND WORKMANSHIP SHALL CONFORM TO THE SPECIFICATIONS FOR BUILDINGS AND ROAD WORKS, ALONG WITH THE REQUIREMENTS OF ALL RELEVANT CODES OF PRACTICE AND STATUTORY AUTHORITIES
- 5. PRIOR TO COMMENCING WORK, VERIFY ALL SETTING-OUT DIMENSIONS WITH THE PROJECT SUPERVISOR
- 6. ANY VARIATIONS OR SUBSTITUTIONS OF MATERIALS OR DETAILS FROM THOSE INDICATED ON THE DRAWINGS
  MAY ONLY BE MADE WITH THE PRIOR APPROVAL OF THE PROJECT SUPERVISOR OR ENGINEER
- 7. IMPLEMENT ALL NECESSARY SAFETY MEASURES TO PROTECT WORKERS AND THE PUBLIC DURING CONSTRUCTION ACTIVITIES
- 8. THE CONTRACTOR SHALL PROVIDE, INSTALL, MAINTAIN, AND REMOVE ALL NECESSARY SHORING. BRACING, AND RELATED SAFETY MEASURES TO PREVENT THE COLLAPSE OF TRENCHES AND EXCAVATIONS
- 9. THE CONTRACTOR SHALL BE RESPONSIBLE FOR ANY DAMAGE OR SETTLEMENT CAUSED BY INADEQUATE SHORING MEASURES AND SHALL RECTIFY SUCH ISSUES AT THEIR OWN EXPENSE

## **ABRIVIATIONS**

C/C	CENTER TO CENTER
FT.	FEET
GI	GALVANIZED IRON
HDPE	HIGH-DENSITY POLYETHYLENE
MM	MILLIMETERS
MSL	MEAN SEA LEVEL
NO.	NUMBER
PVC	POLY VINYL CHLORIDE
RF	REINFORCEMENT
THK	THICK
W/	WITH
Φ	DIAMETER

INCHES

## **GRAPHICS LEGEND**

SYMBOL	MATERIAL	SYMBOL	MATERIAL
	08 INCH PIPELINE		12 INCH PIPELINE
	COMPACTED EARTH		CONCRETE IN SECTION
	GRAVEL IN PLAN		GRAVEL IN SECTION
	MASONRY IN PLAN		MASONRY IN SECTION
	SOIL IN PLAN		SOIL IN SECTION

## DRAWING SYMBOLS



SECTION NUMBER
SHEET NUMBER



DETAIL NUMBER
SHEET NUMBER



ELEVATION MARK



REVISION NUMBER



COLLECTION PIT NUMBER



JUNCTION NUMBER



SLOPE DIRECTION

PROJECT:	
DEVELOPMENT OF STORM WATER	DRAINAGE
INFRASTRUCTURE AT KULHUDHUF	FUSHI CITY

CLIENT: KULHUDHUFFUSHI CITY COUNCIL


COVER & INDEX SHEET


A-001 SCALE: -- REVISION NO: 00

DATE: 17/06/2025 ISSUED FOR: TENDERING

NOTES:

--

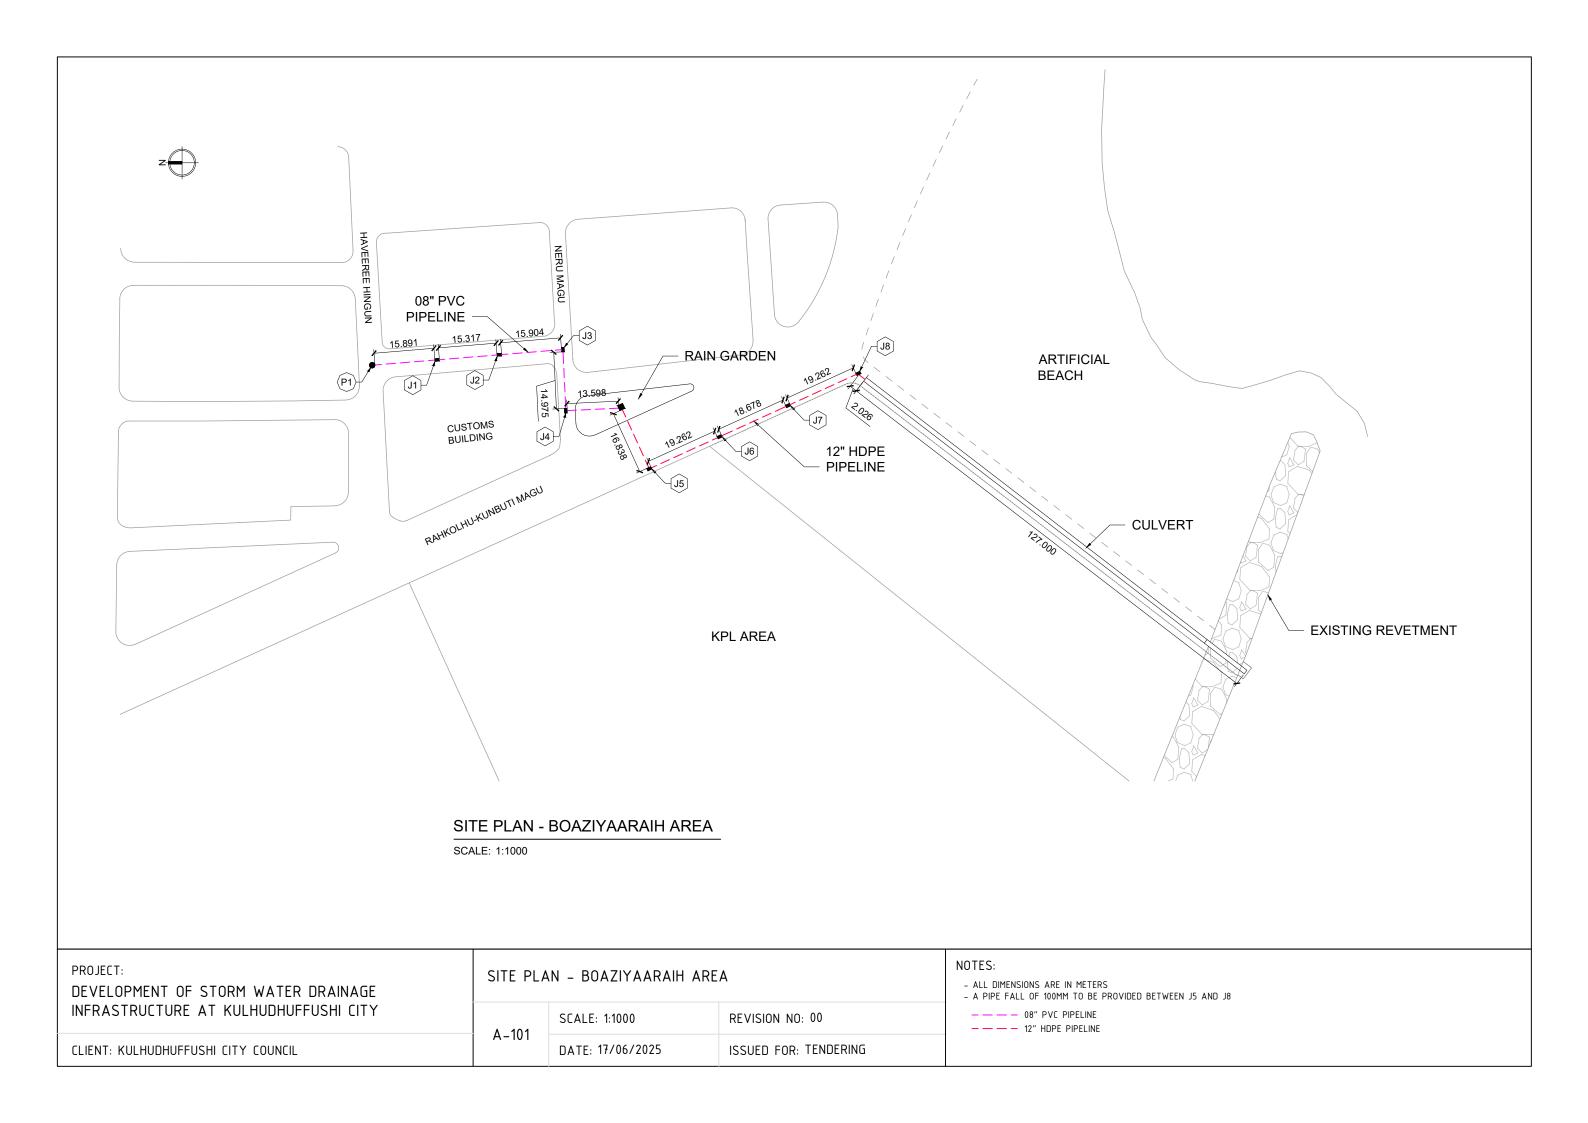


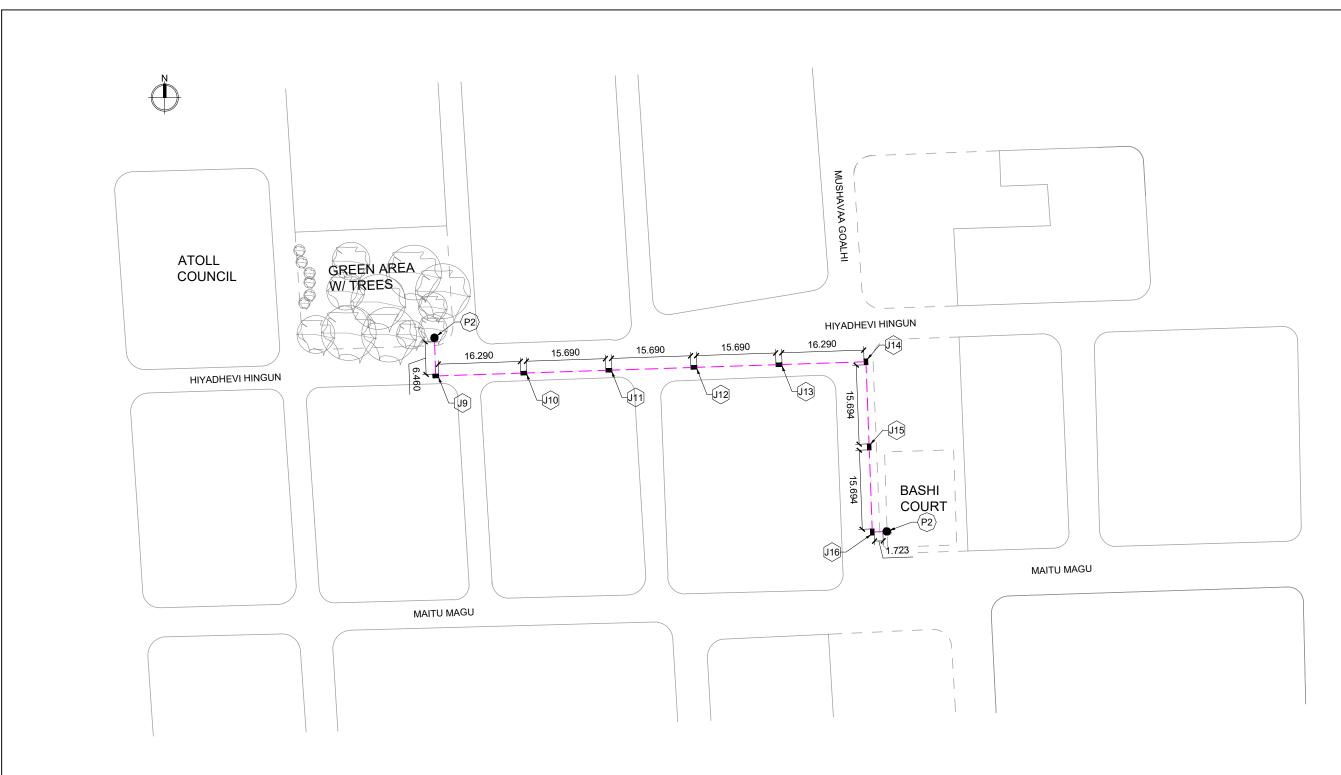


# SITE PLAN - ATOLL COUNCIL AREA


SCALE: 1:750

PROJECT: DEVELOPMENT OF STORM WATER DRAINAGE	SITE PLA	AN – ATOLL COUNCIL ARE	ĒΑ	NOTES:  - ALL DIMENSIONS ARE IN METERS	
	INFRASTRUCTURE AT KULHUDHUFFUSHI CITY	A 102	SCALE: 1:750	REVISION NO: 00	— — — 08" PVC PIPELINE
	CLIENT: KULHUDHUFFUSHI CITY COUNCIL	A-102	DATE: 17/06/2025	ISSUED FOR: TENDERING	

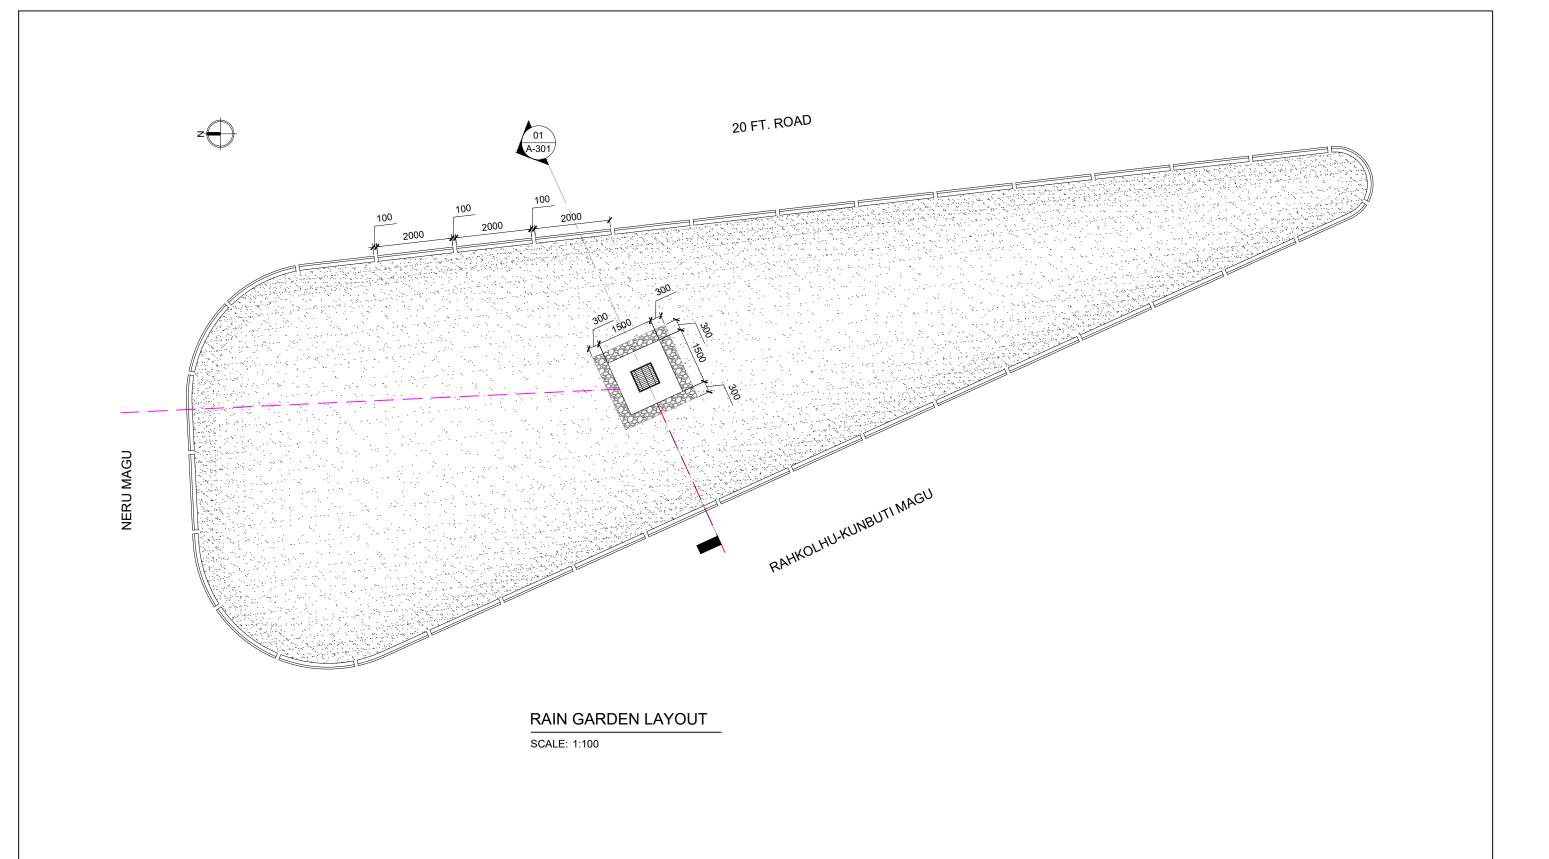

PROJECT: DEVELOPMENT OF STORM WATER DRAINAGE	RAIN GA	RDEN LAYOUT		NOTES:  - ALL DIMENSIONS ARE IN MILLIMETERS
INFRASTRUCTURE AT KULHUDHUFFUSHI CITY	A 103	SCALE: 1:100	REVISION NO: 00	08" PVC PIPELINE 12" HDPE PIPELINE
CLIENT: KULHUDHUFFUSHI CITY COUNCIL	A-103	DATE: 17/06/2025	ISSUED FOR: TENDERING	

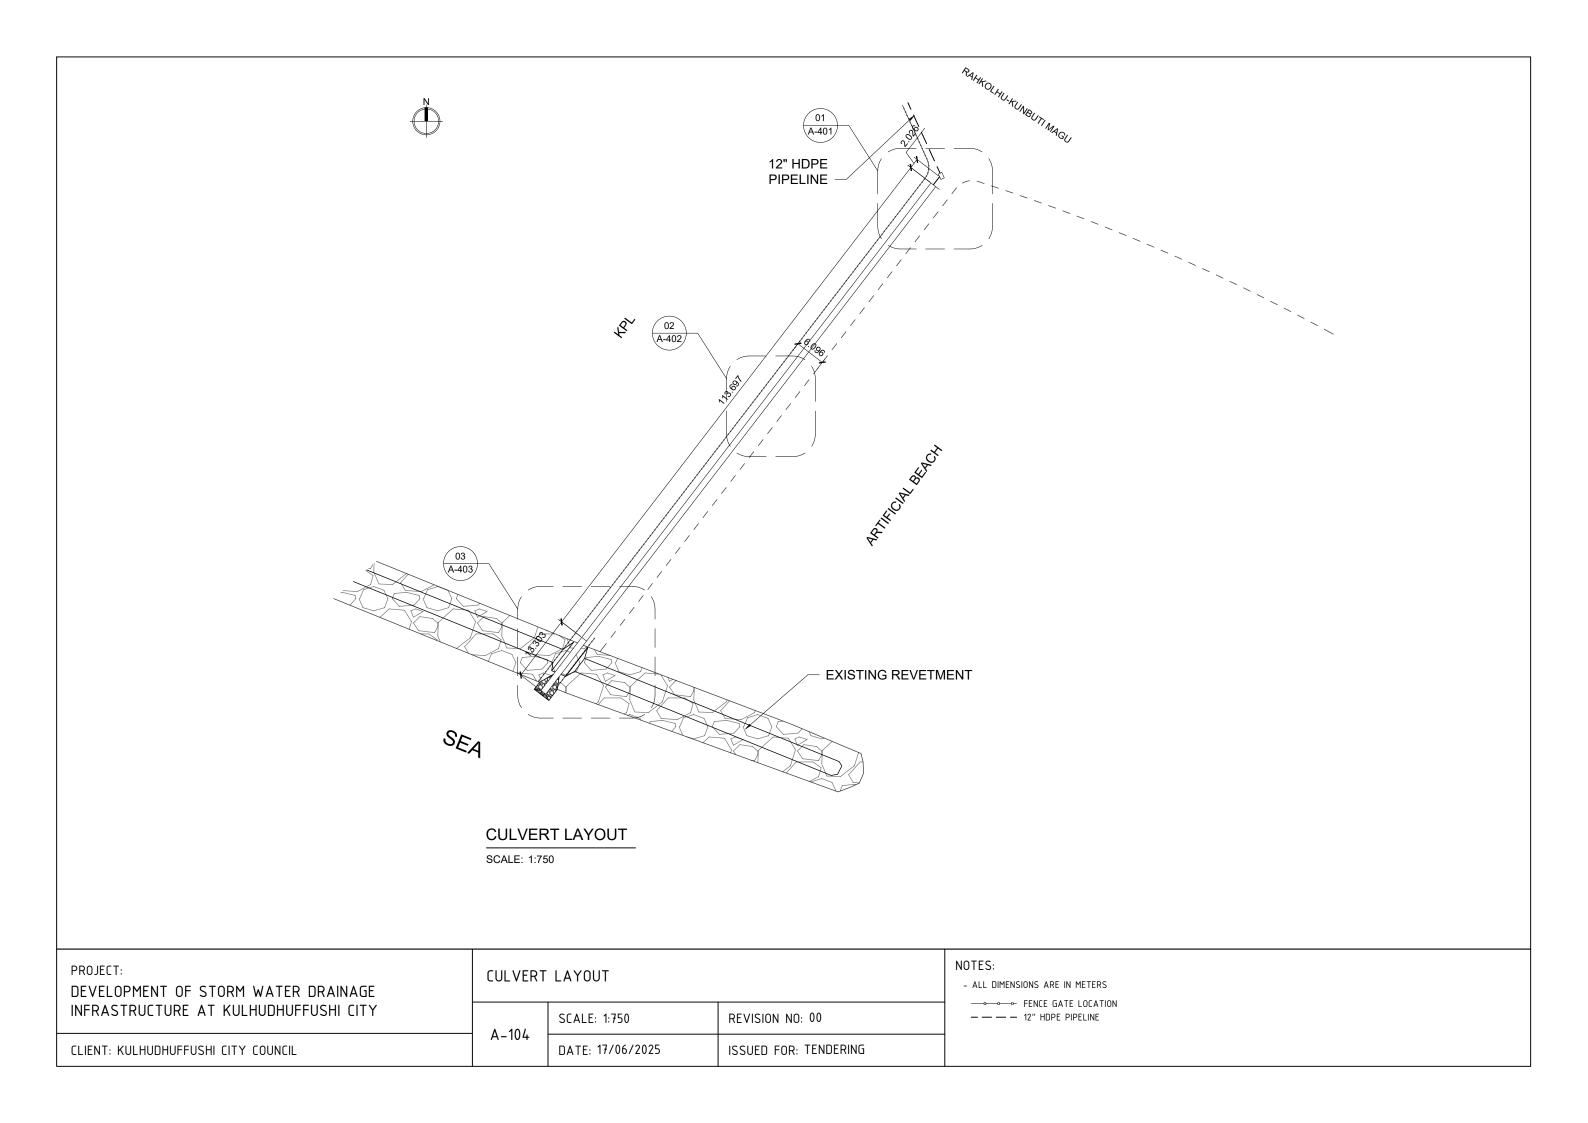

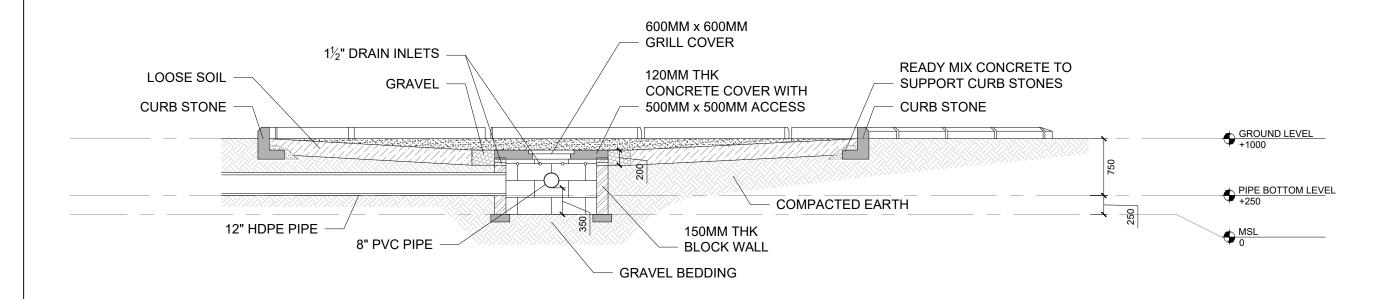

## SECTION 01 - RAIN GARDEN DETAILS


SCALE: 1:50


### WELL COVER RF DETAILS:

- 50 MM COVER TO BE PROVIDED
- T10 @ 150 C/C BW, SINGLE MESH
- EXTRA BARS TO BE PROVIDED AROUND VOIDS

PROJECT: DEVELOPMENT OF STORM WATER DRAINAGE	SECTION	SECTION 01 - RAIN GARDEN DETAILS			
INFRASTRUCTURE AT KULHUDHUFFUSHI CITY	A-301	SCALE: 1:50	REVISION NO: 00		
CLIENT: KULHUDHUFFUSHI CITY COUNCIL	A-301	DATE: 17/06/2025	ISSUED FOR: TENDERING		

## NOTES:

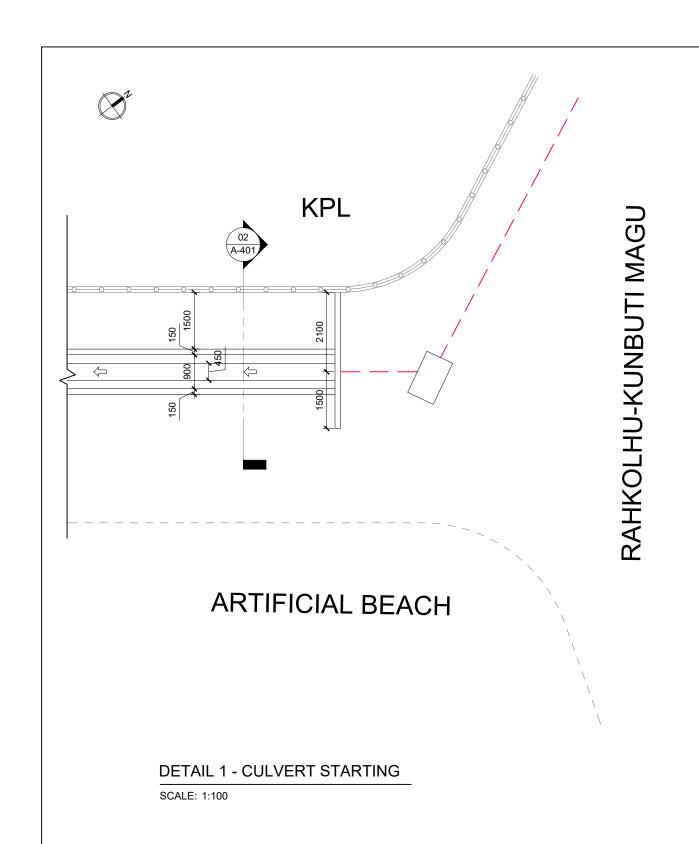


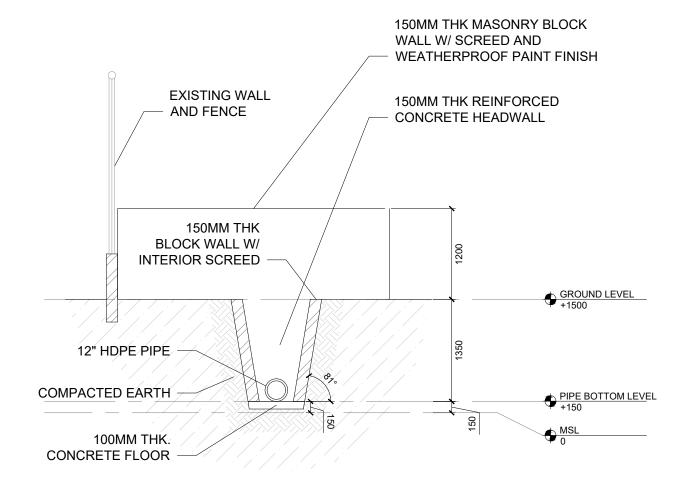

### SECTION 2 - CULVERT STARTING

SCALE: 1:50


PROJECT: DEVELOPMENT OF STORM WATER DRAINAGE	CULVER <sup>-</sup>	T START DETAILS		NOTES:  - ALL DIMENSIONS ARE IN MILLIMETERS
INFRASTRUCTURE AT KULHUDHUFFUSHI CITY	A-401	SCALE: AS GIVEN	REVISION NO: 00	FENCE GATE LOCATION  — — — 12" HDPE PIPELINE
CLIENT: KULHUDHUFFUSHI CITY COUNCIL	A-401	DATE: 17/06/2025	ISSUED FOR: TENDERING	

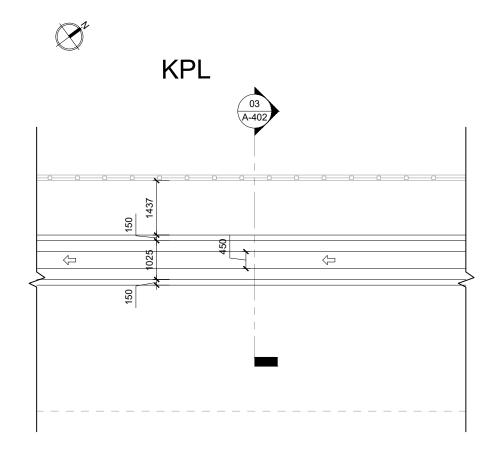

# ARTIFICIAL BEACH

DETAIL 2 - CULVERT MIDDLE

SCALE: 1:100

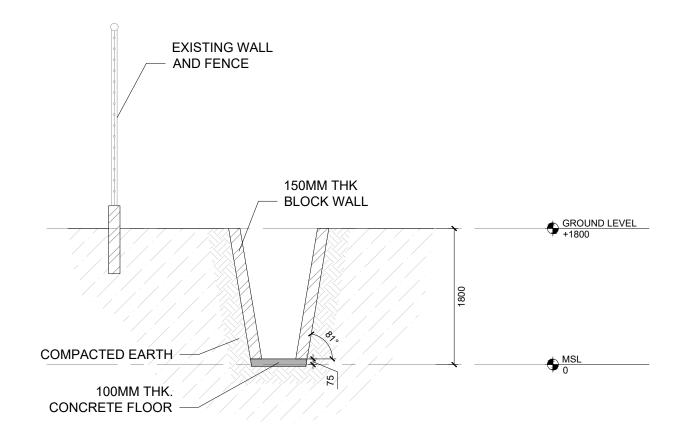



## **SECTION 3 - CULVERT MIDDLE**

SCALE: 1:50

PROJECT: DEVELOPMENT OF STORM WATER DRAINAGE	CULVERT MIDDLE DETAIL			
INFRASTRUCTURE AT KULHUDHUFFUSHI CITY	A / 02	SCALE: AS GIVEN	REVISION NO: 00	
CLIENT: KULHUDHUFFUSHI CITY COUNCIL	A-402	DATE: 17/06/2025	ISSUED FOR: TENDERING	

NOTES:

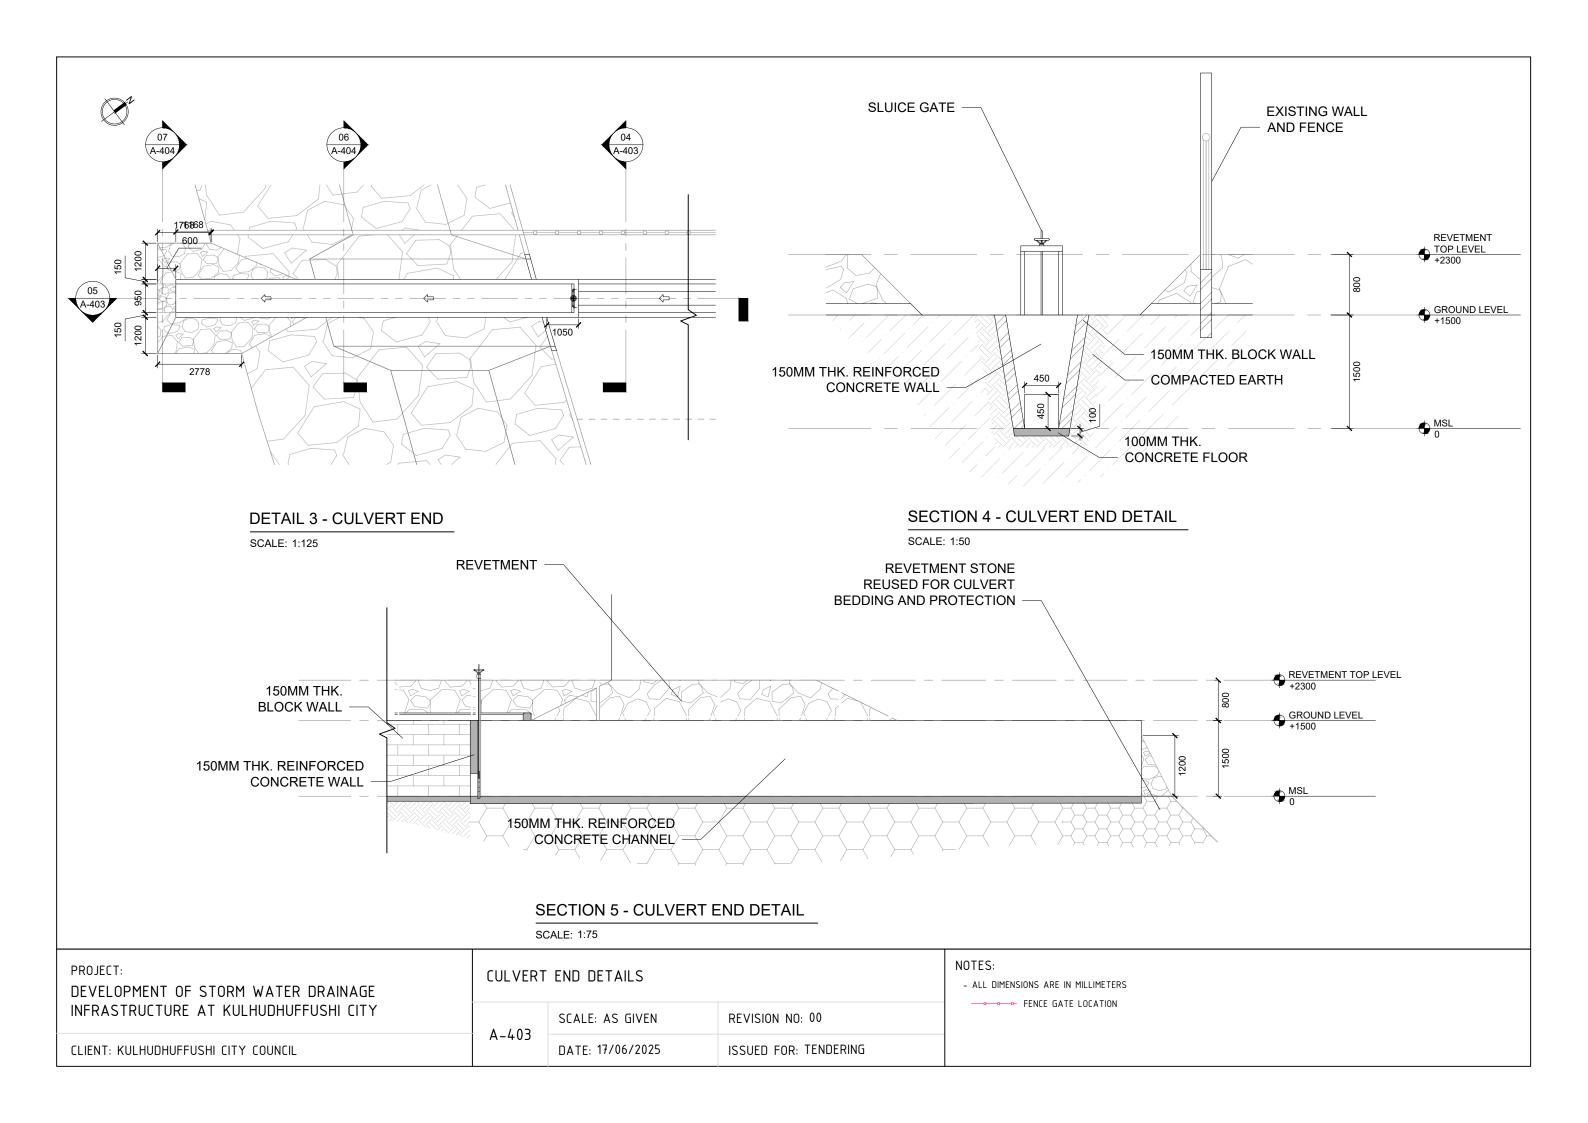

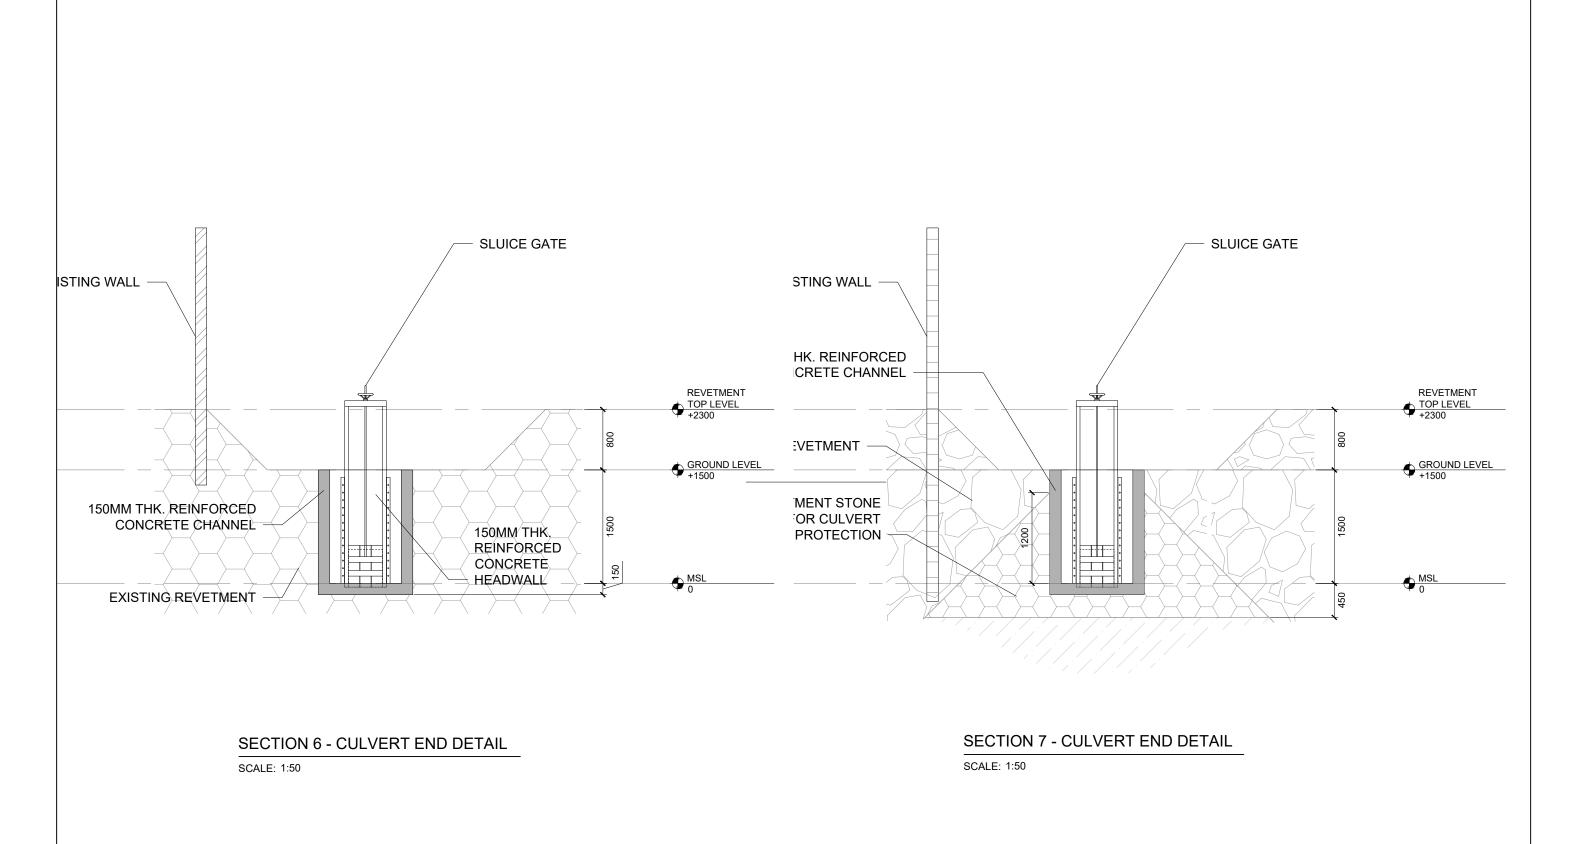

PROJECT:	CULVERT END DETAILS	NOT
DEVELOPMENT OF STORM WATER DRAINAGE		

CLIENT: KULHUDHUFFUSHI CITY COUNCIL

INFRASTRUCTURE AT KULHUDHUFFUSHI CITY

A-404

SCALE: AS GIVEN


REVISION NO: 00

DATE: 17/06/2025

ISSUED FOR: TENDERING

### NOTES:



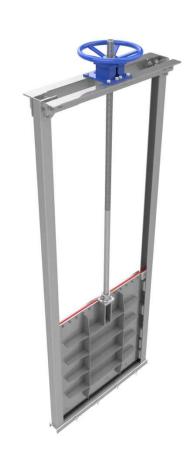



PROJECT:			
DEVELOPMENT	OF STORM	WATER DRAIL	NAGE
INFRASTRUCTU	RE AT KUL	HUDHUFFUSHI	CITY


CLIENT	12111-1	UIDIUIEEI	10111 0	T. /	COLINICII
LLIENI:	KULF	IUDHUFFL	JSHI LI	ΗΥI	LUUNLIL


## SLUICE GATE SAMPLE


REVISION NO: 00 SCALE: --A-501 DATE: 17/06/2025 ISSUED FOR: TENDERING


### NOTES:


- DRAWING IS NOT TO SCALE THE SLUICE GATE ILLUSTRATION PROVIDED IS A SAMPLE FOR THE CONTRACTORS REFERENCE FINAL SLUICE GATE DESIGN TO BE APPROVED BY THE PROJECT SUPERVISOR

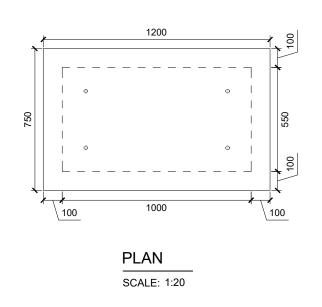

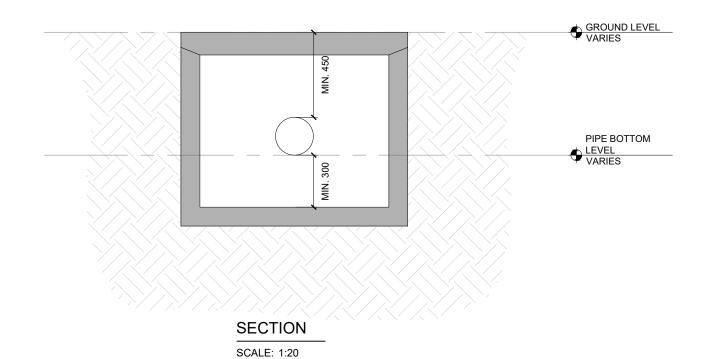

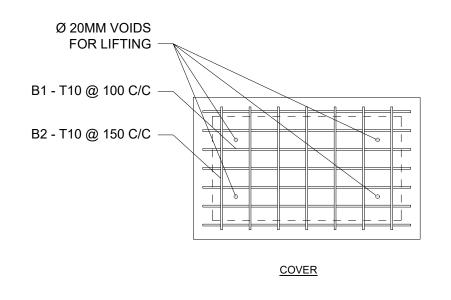

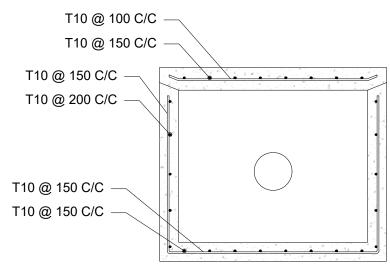

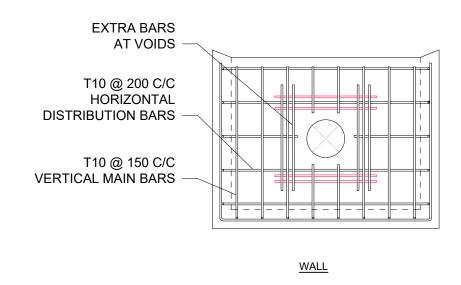

## REINFORCEMENT DETAILS


SCALE: 1:20


PROJECT:  DEVELOPMENT OF STORM WATER DRAINAGE INFRASTRUCTURE AT KULHUDHUFFUSHI CITY
CLIENT: KULHUDHUFFUSHI CITY COUNCIL

JUNCTION PIT DETAILS				
S-501	SCALE: AS GIVEN	REVISION NO: 00		
5-501	DATE: 17/06/2025	ISSUED FOR: TENDERING		

#### NOTES:


- ALL DIMENSIONS ARE IN MILLIMETERS 50MM COVER TO BE PROVIDED FOR CONCRETE STRUCTURES IN CONTACT WITH THE GROUND

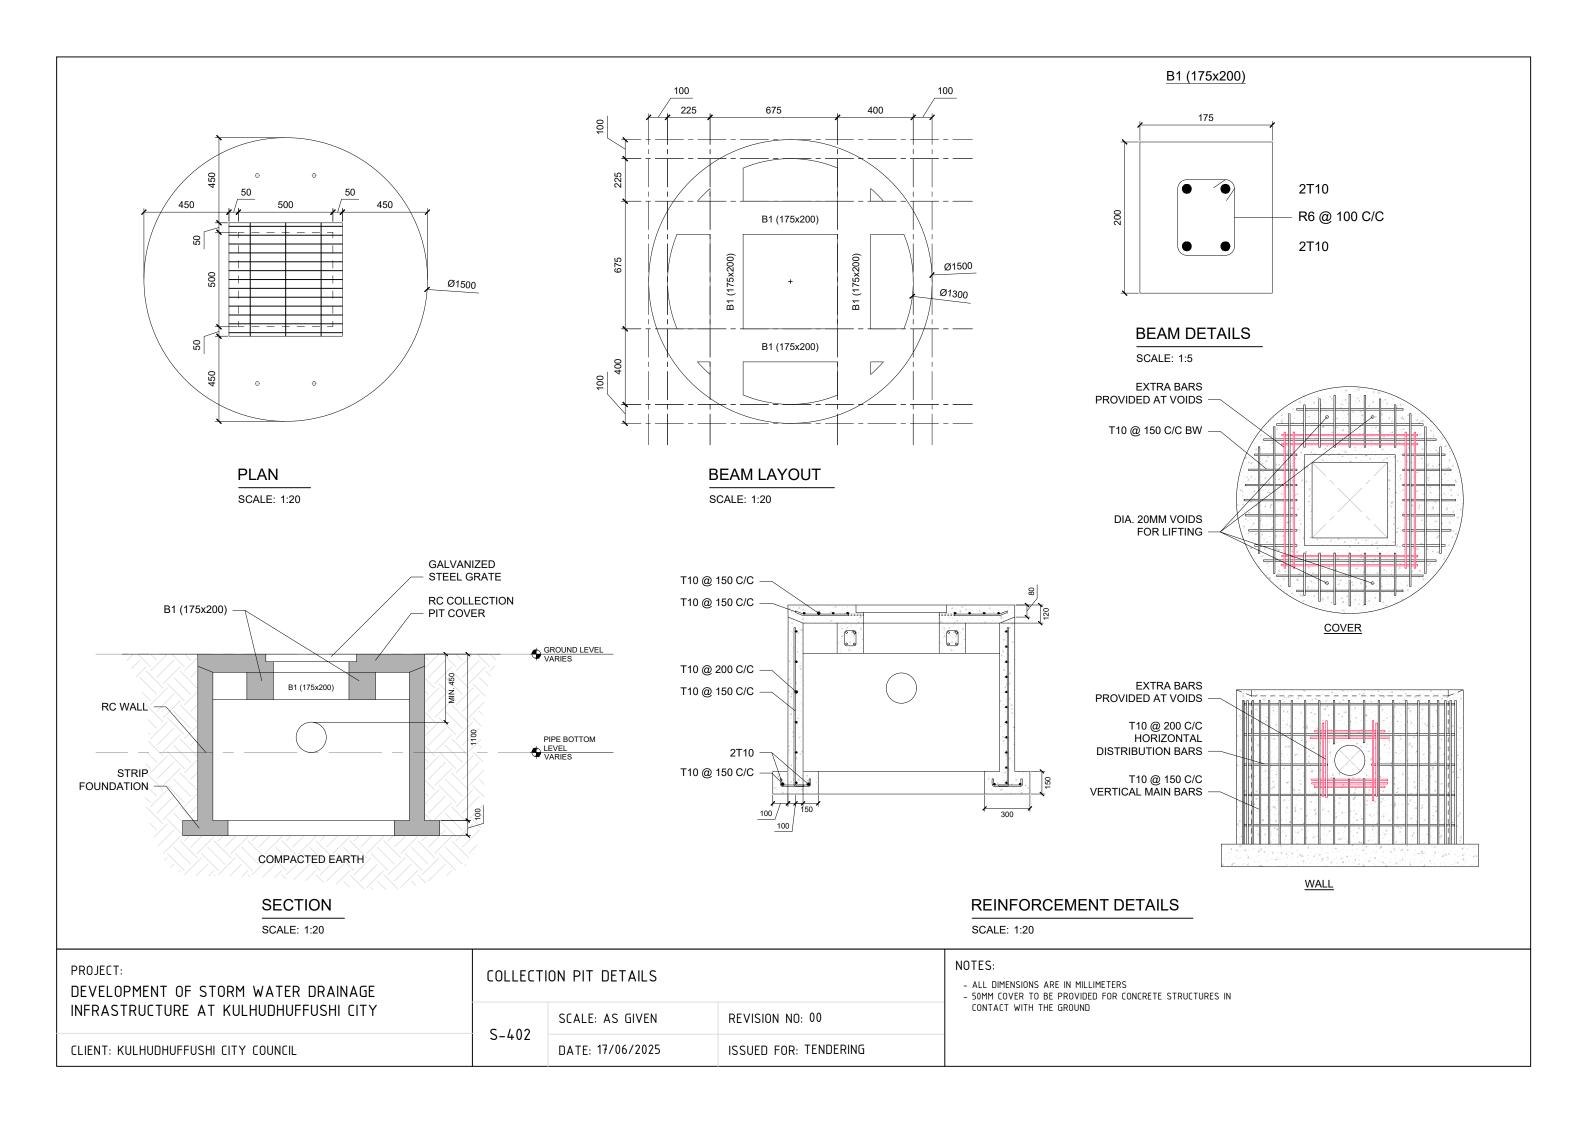

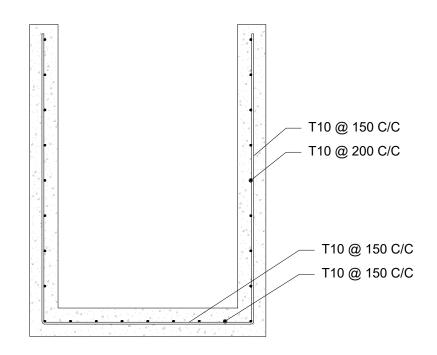

## CULVERT CHANNEL REINFORCEMENT DETAIL


SCALE: 1:20

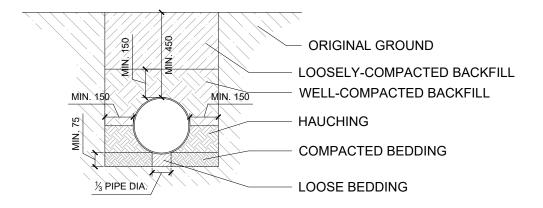


## TYPICAL PIPE TRENCH DETAIL

SCALE: 1:20

	PROJECT:  DEVELOPMENT OF STORM WATER DRAINAGE INFRASTRUCTURE AT KULHUDHUFFUSHI CITY  CLIENT: KULHUDHUFFUSHI CITY COUNCIL	TYPICAL DETAIL DIAGRAMS			
		S-501	SCALE: AS GIVEN	REVISION NO: 00	
			DATE: 17/06/2025	ISSUED FOR: TENDERING	

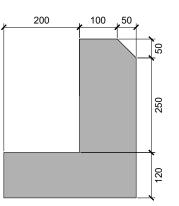

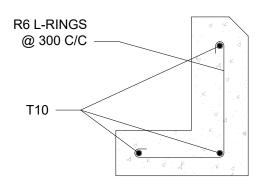

## TYPICAL CURB STONE DETAILS

SCALE: 1:10

NO	TE	S	: